






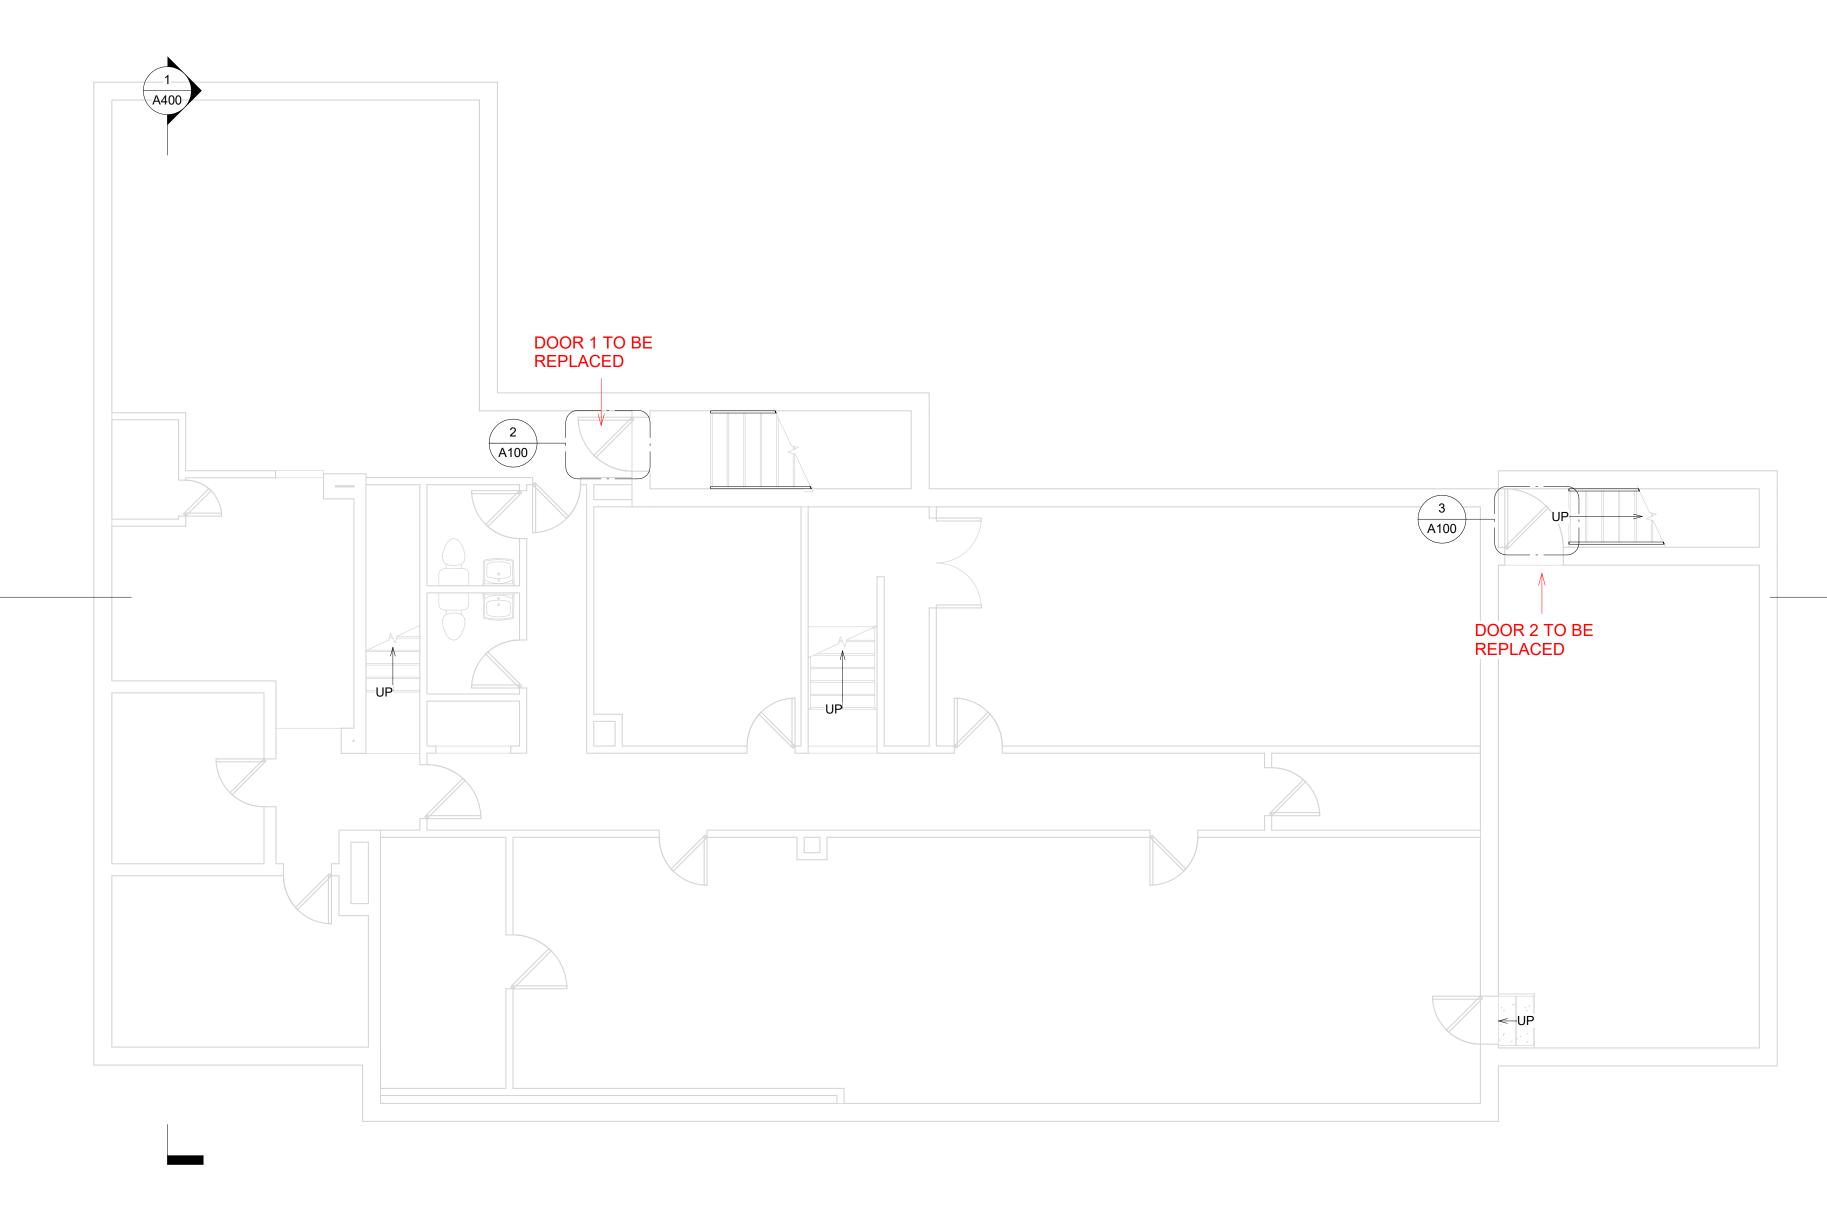



1 EXISTING BASEMENT A100 SCALE: 3/16" = 1'-0"




	D	OC	R SCHE	D	ULE1	
		PANEL				HARDWARE
MARK	Level	١	NIDTH	H	IEIGHT	SET
DOOR 1	BASEMENT		3'-0"		6'-8"	1
DOOR 2	BASEMENT		3'-3"		6'-8"	1
1: 2						
DOOR 3	FIRST FLOOR		3'-0"		6'-8"	1
1: 1		_				
DOOR 4	FIRST FLOOR		3'-0"		7'-0"	2
2: 1						
DOOR 5	FIRST FLOOR		5'-8"		7'-0"	3
3: 1						
DOOR 10	FIRST FLOOR		5'-0"		7'-0"	4
DOOR 9	FIRST FLOOR		5'-0"		7'-0"	4
4: 2 GRAND TOTAL	: 7					
	WI	ND	OW SCI	HE	DULE	
			ι	JN	IT	
			DIME	N	SIONS	
NUMBE	r Type	Ξ	HEIGH	Т	WIDTH	REMARKS
1	D		7'-0"		5'-0"	NEW WINDOW
2	D		7'-0"		5'-0"	NEW WINDOW
GRAND TOTAL	:2					

	NOTE		
	NOTE: 1.THE CONTRACTOR MUST		K
	VERIFY ALL DIMENSIONS IN		PLATO
	THE FIELD PRIOR TO		STUDIO
	ORDERING AND		#L SI U DI U
	INSTALLATION.		PLATO
	2. DOORS SLABS AND FRMASE TO BE REPLACED FOLLOWING		
	THE PROPOSED HARDWARE		MARINAKOS, JR.
	SET		ARCHITECT, LLC
			www.plata_studio_aom
			www.plato-studio.com
			1617 JFK BLVD 20th Floor
			Philadelphia, PA 19103
			888-312-5369 OFFICE 267-866-0931 DIRECT
			plato@plato-studio.com
			ISSUED FOR
			BIDDING
			5/31/24
2			
A400			
•			ARCHITECT SEAL MUST BE IN RED INK
		0	OWNER
			Vision Acadomy Charter
			Vision Academy Charter
			School
			ONE CALL #:
			DINITION OF THE PROVIDE THE PROVID
			Know what's below.
			Call before you dig.
			SITE SAFETY
		It	It is the responsibility of the general contractor and/or the contractor listed a
			the licensed entity of the building permit per the municipality to ensure all site safety requirements are in place and followed, prior to, during, and afte
			the commencement of the construction process until they are 100% complete and have received a building certificate of occupancy by governing
			agencies. They are also responsible for any unsafe conditions caused by or related to their sub contractors' work. Plato Marinakos, Architect LLC. and
			their professional consultants (associated with these documents) are not responsible for means and methods of construction, and/or site safety;
			including, but not limited to, osha construction safety requirements, standar construction, job site safety, job site safety training of workers, safe work
			site organization, safety direction and/or safety engineering of required safety elements. It is the sole responsibility of the licensed contractor to
			ensure that all site safety measures are in accordance with the governing authorities. Please refer to OSHA website (www.osha.gov) for additional training and information requirements for site safety compliance.
		R	REV DATE DESCRIPTION
			APPROVAL STAMP
			716 EMERSON AVE -
			RECTORY
			FLOOR PLANS
	$\langle D \rangle$		Project number Project Number
	AWNING DOUBLE		Date 5/31/24
			Drawn by Author Checked by Checker
	W TYPES		A100
SCALE: 1/2		s	Scale As indicated

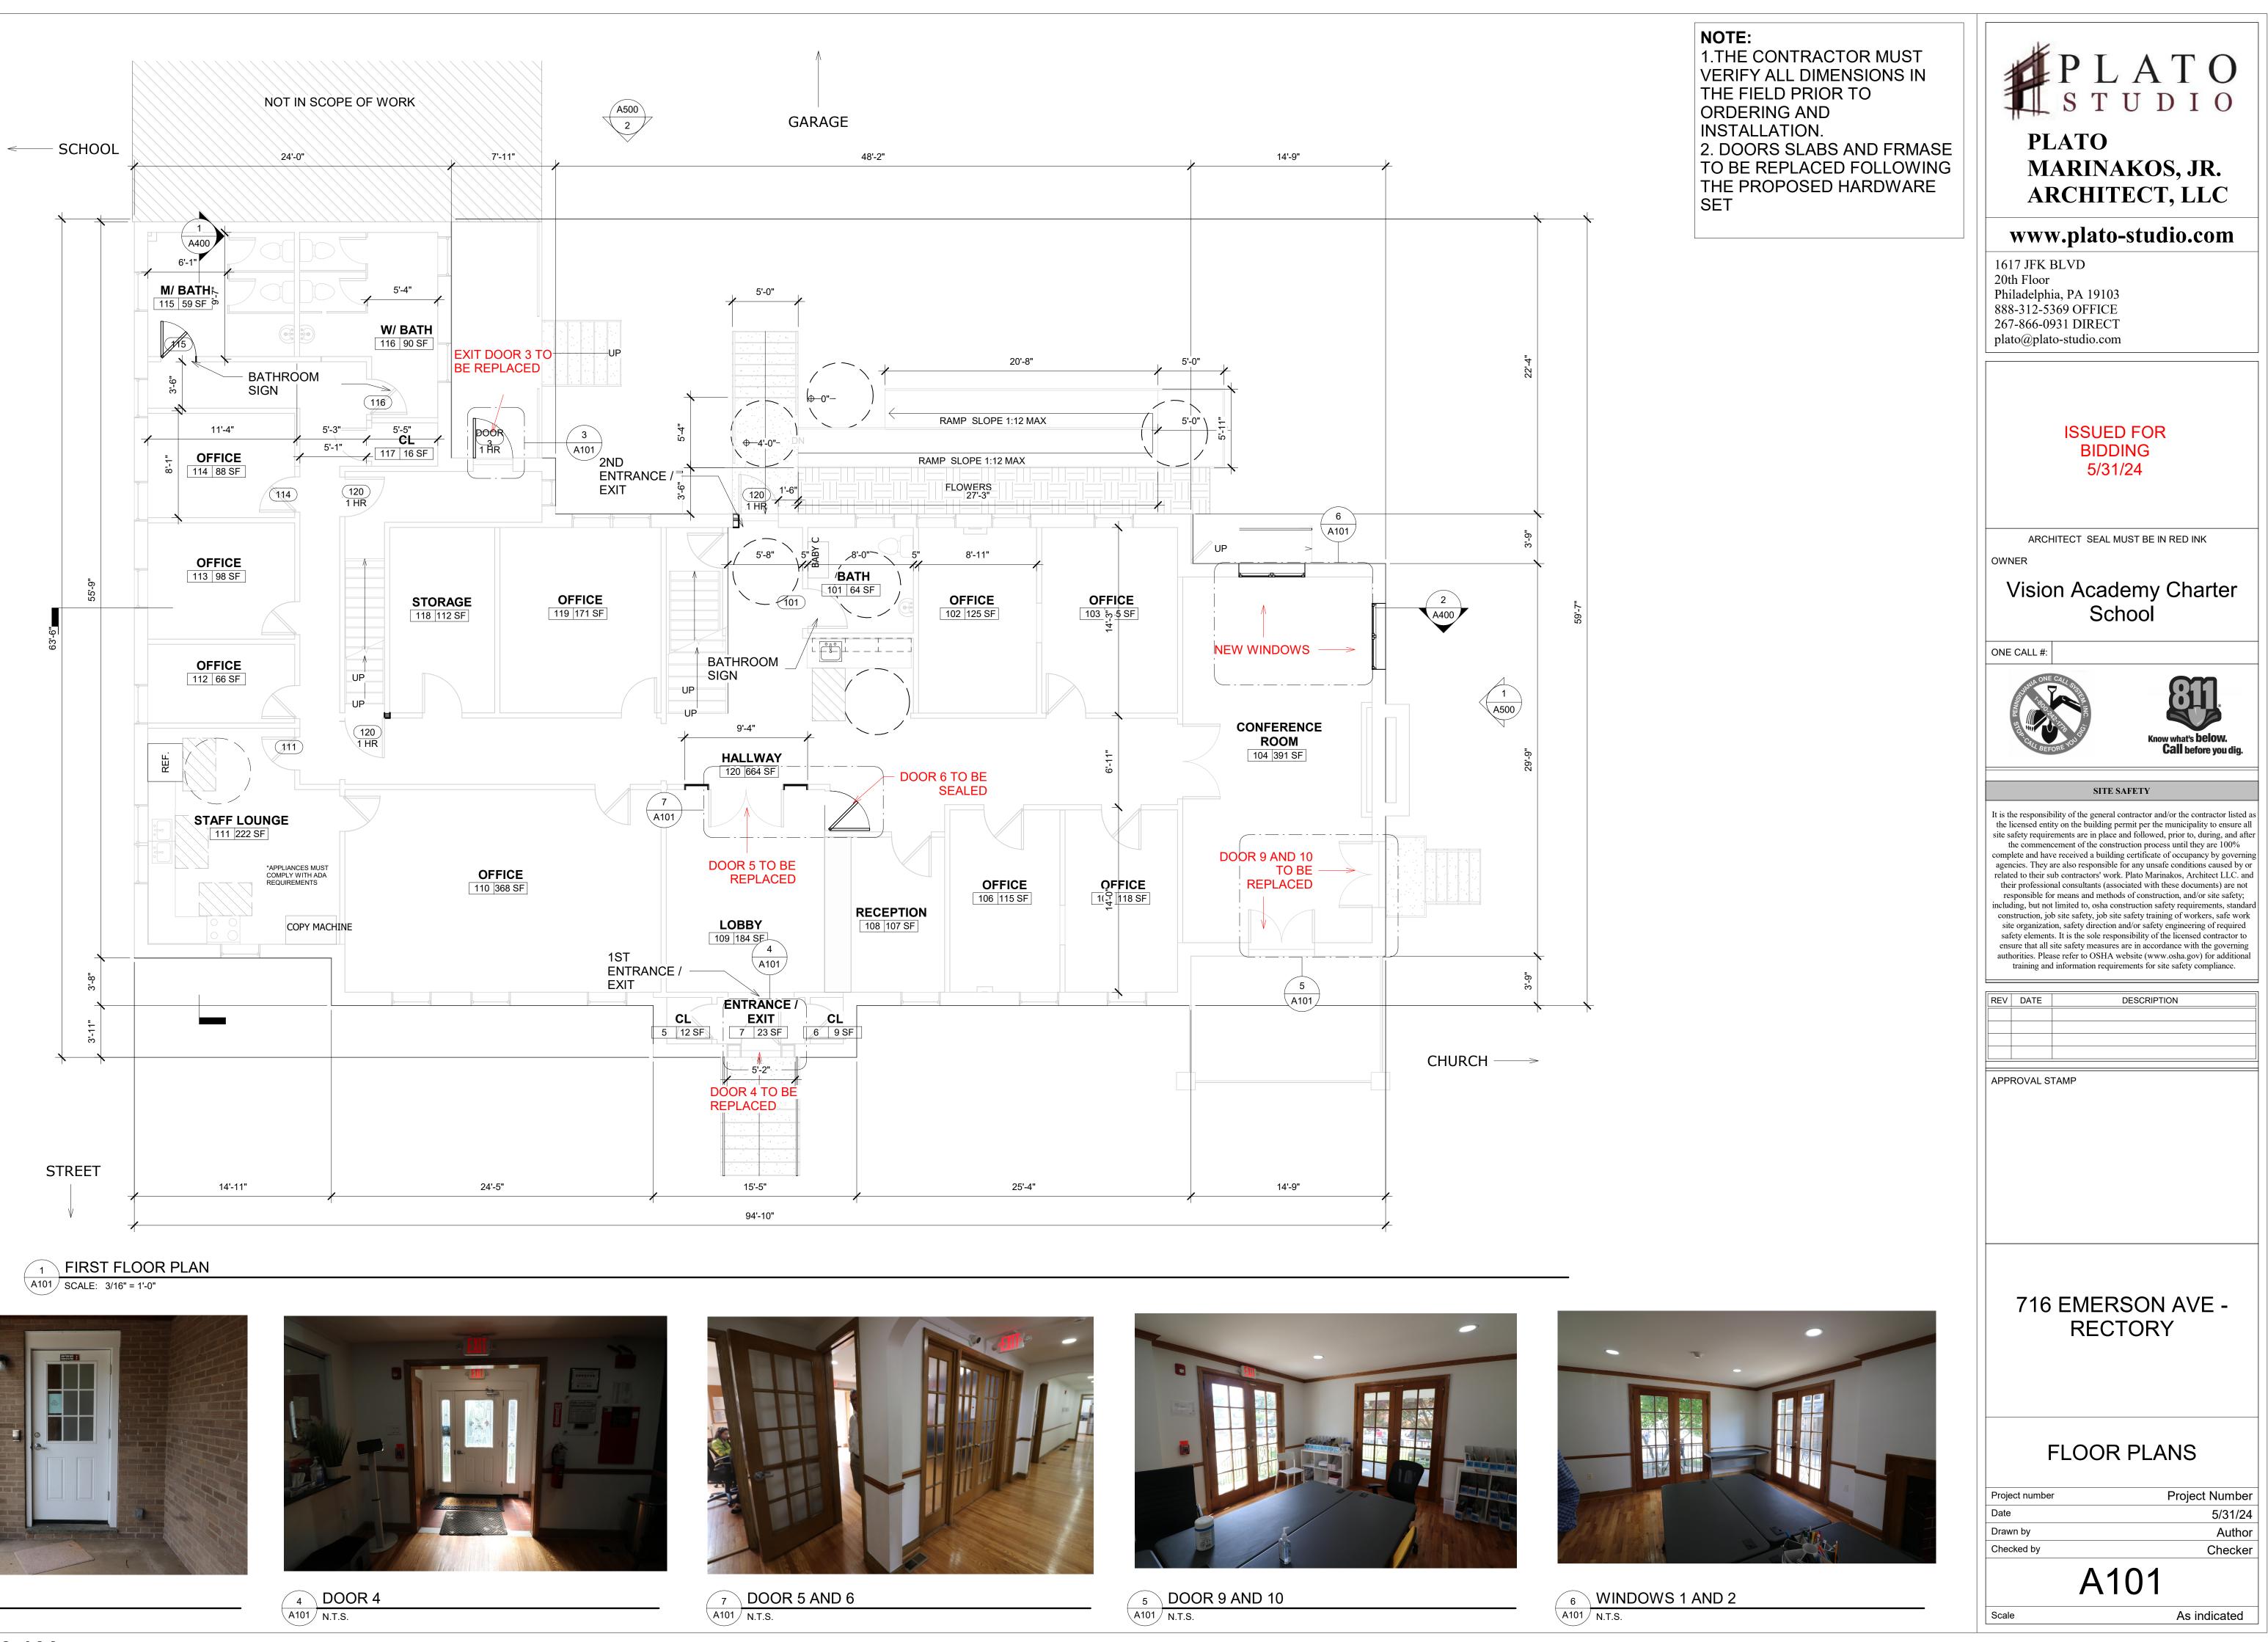

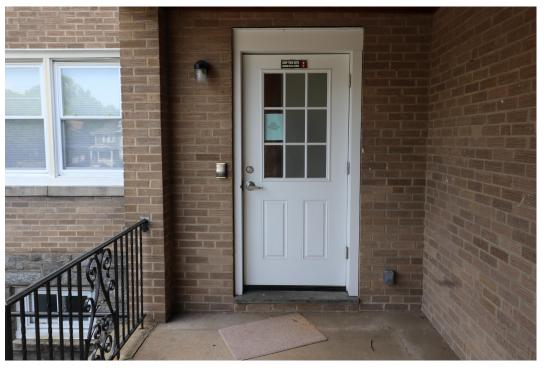


3 DOOR 3 A101 N.T.S.

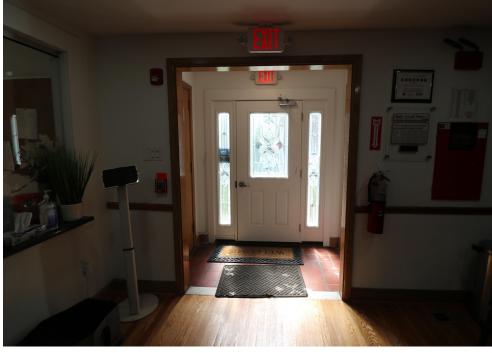


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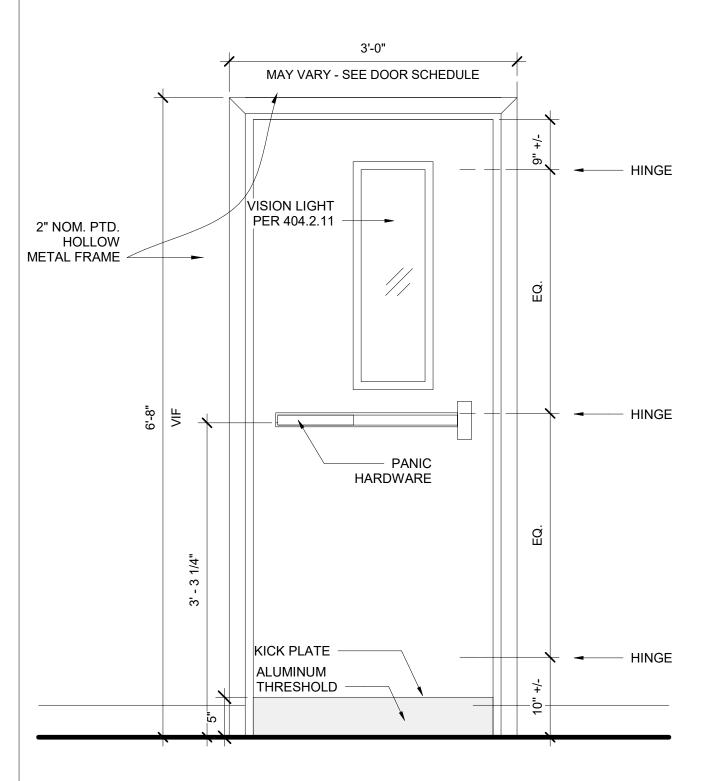




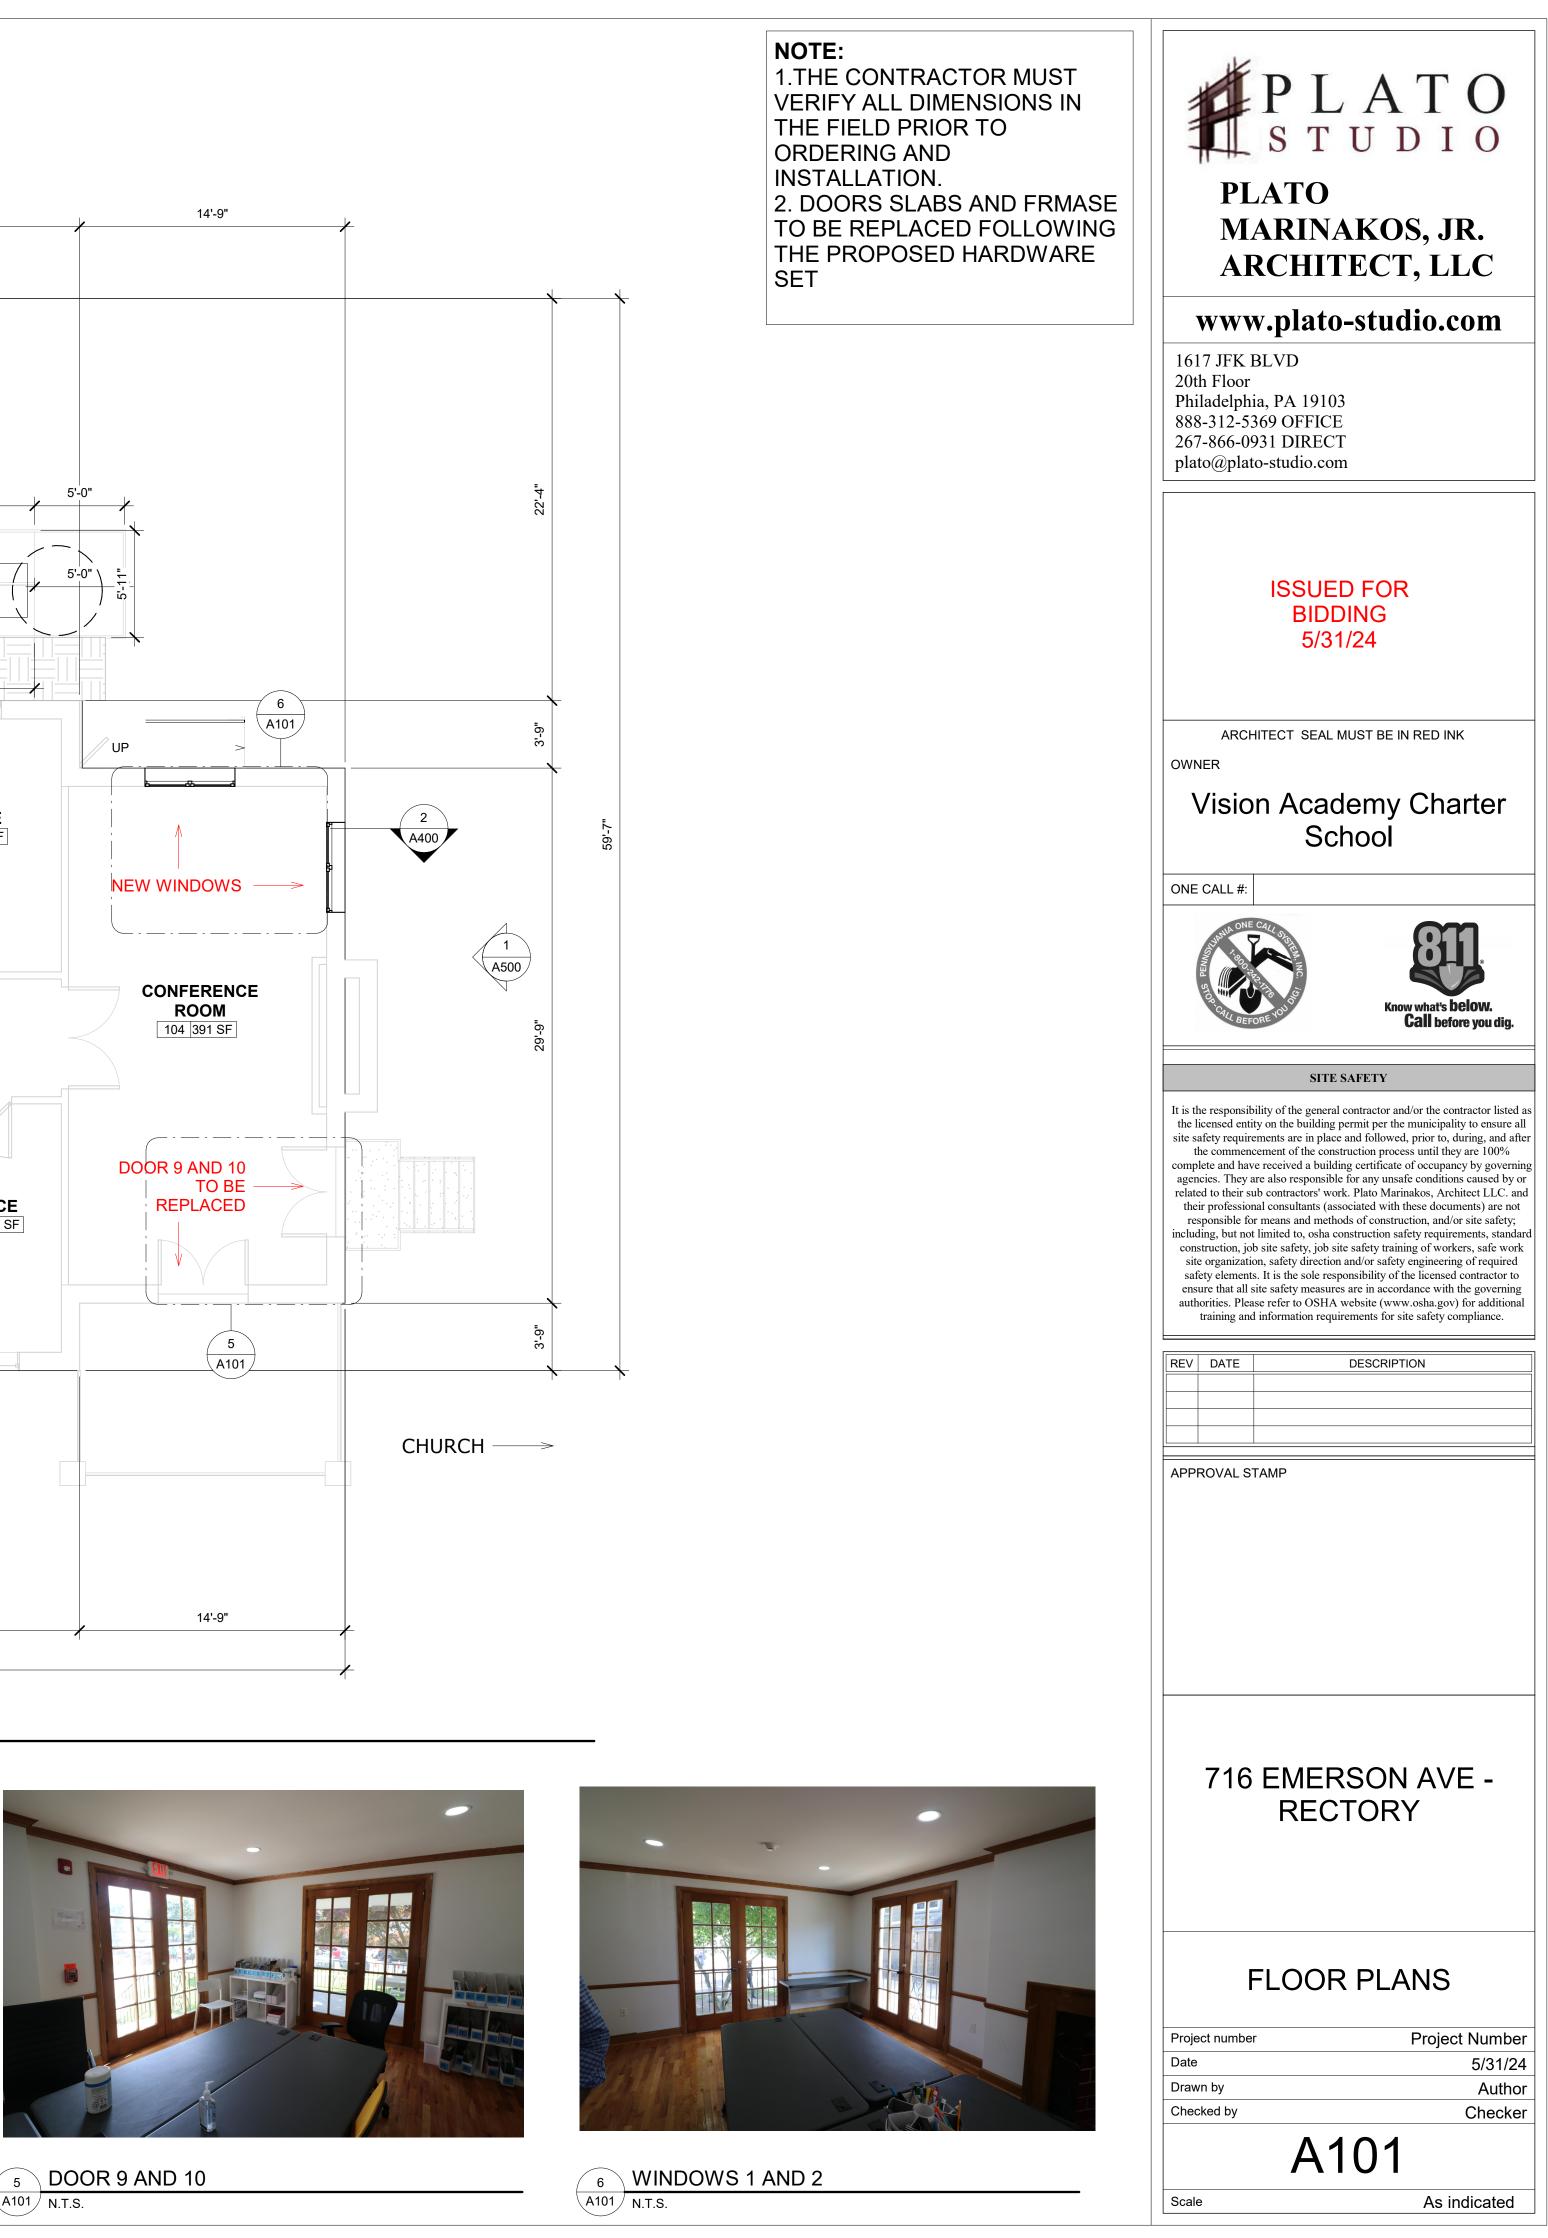

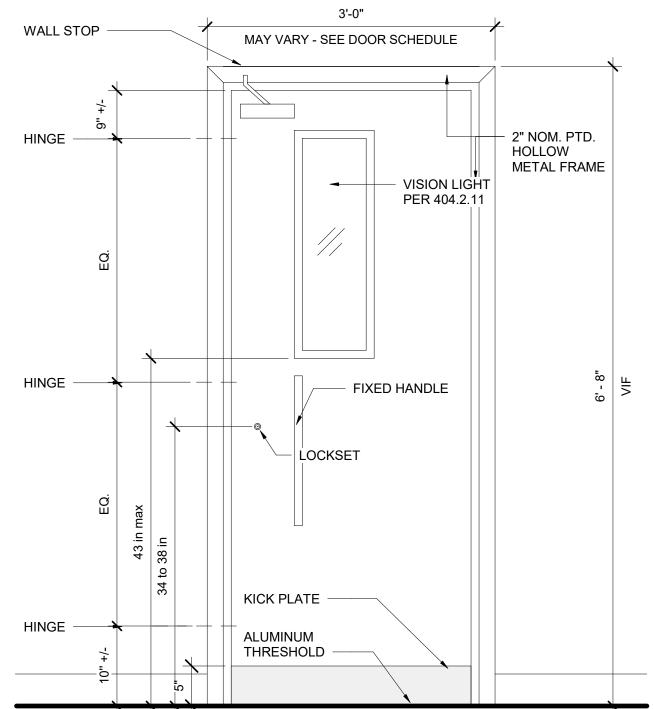

OUTSIDE THE BUILDING




INSIDE THE BUILDING


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DOOR HARDWARE SET 2

GENERAL RATED) 6.DOOR CLOSER

ALUMINIUM



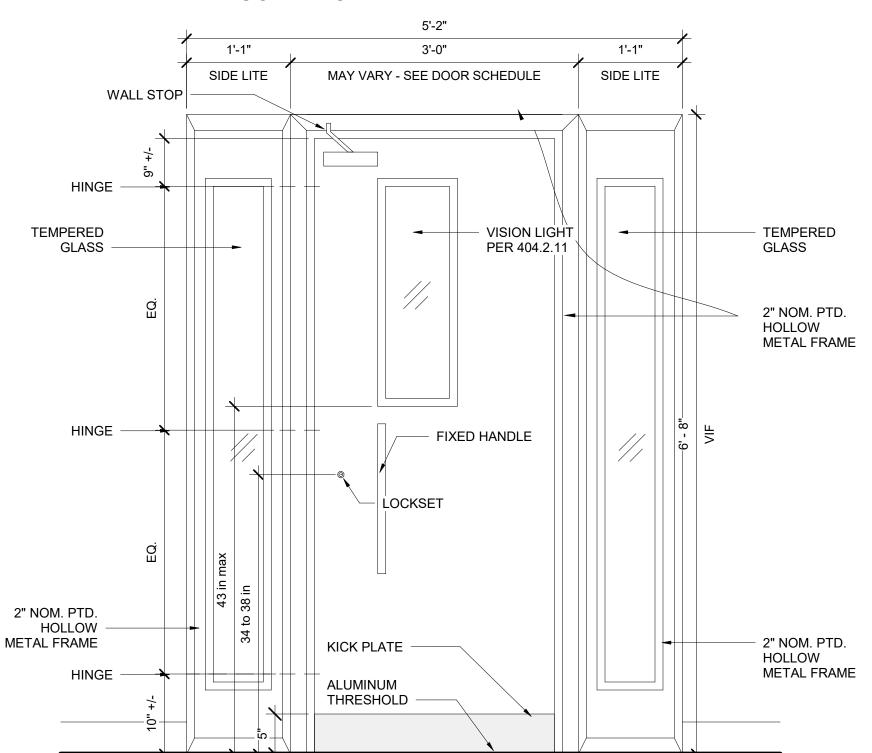

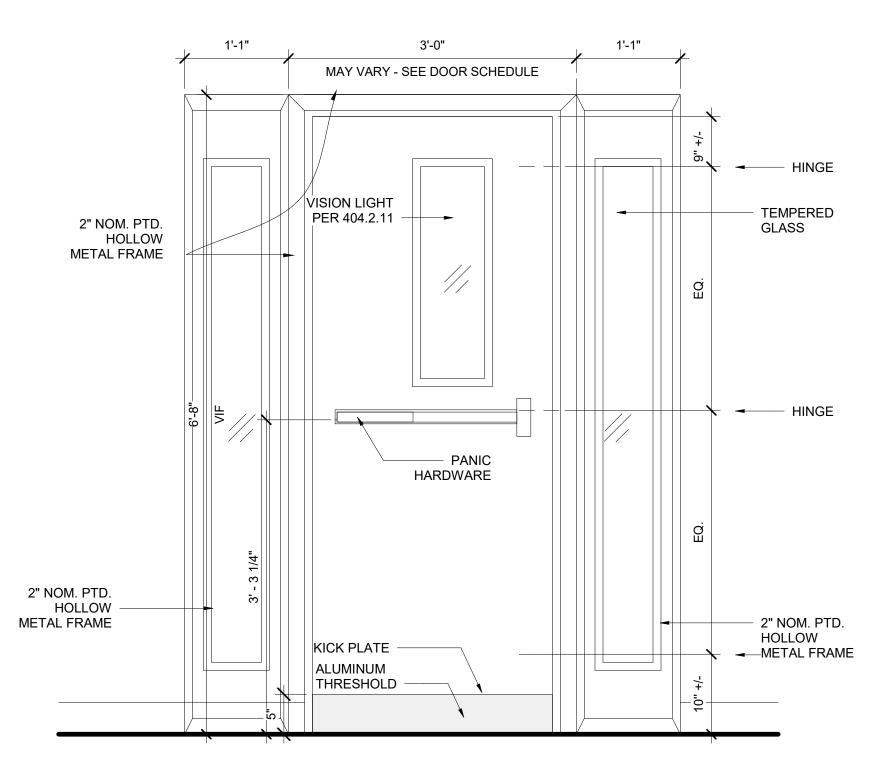INSIDE THE BUILDING


1.DOOR HUNG TO THE FRAME WITH HINGES 2.PANIC HARDWARE WITH LOCKSET **3.THRESHOLD NEEDED** 4.SEALED AND PROTECTED DOOR (1HR


5.NOT ELECTRIFIED DOOR 7.DOOR MUST BE SEALED

SPECIFIC CONSIDERATIONS 1. HEAVY FREQUENCY OF USE 2. EXPOSED TO WEATHER/CLIMATE 3. MATERIAL: TEMPERED GLASS AND

4. VERIFY DOOR SING DIRECTION ON EXISTING CONDITIONS PLAN

OUTSIDE THE BUILDING

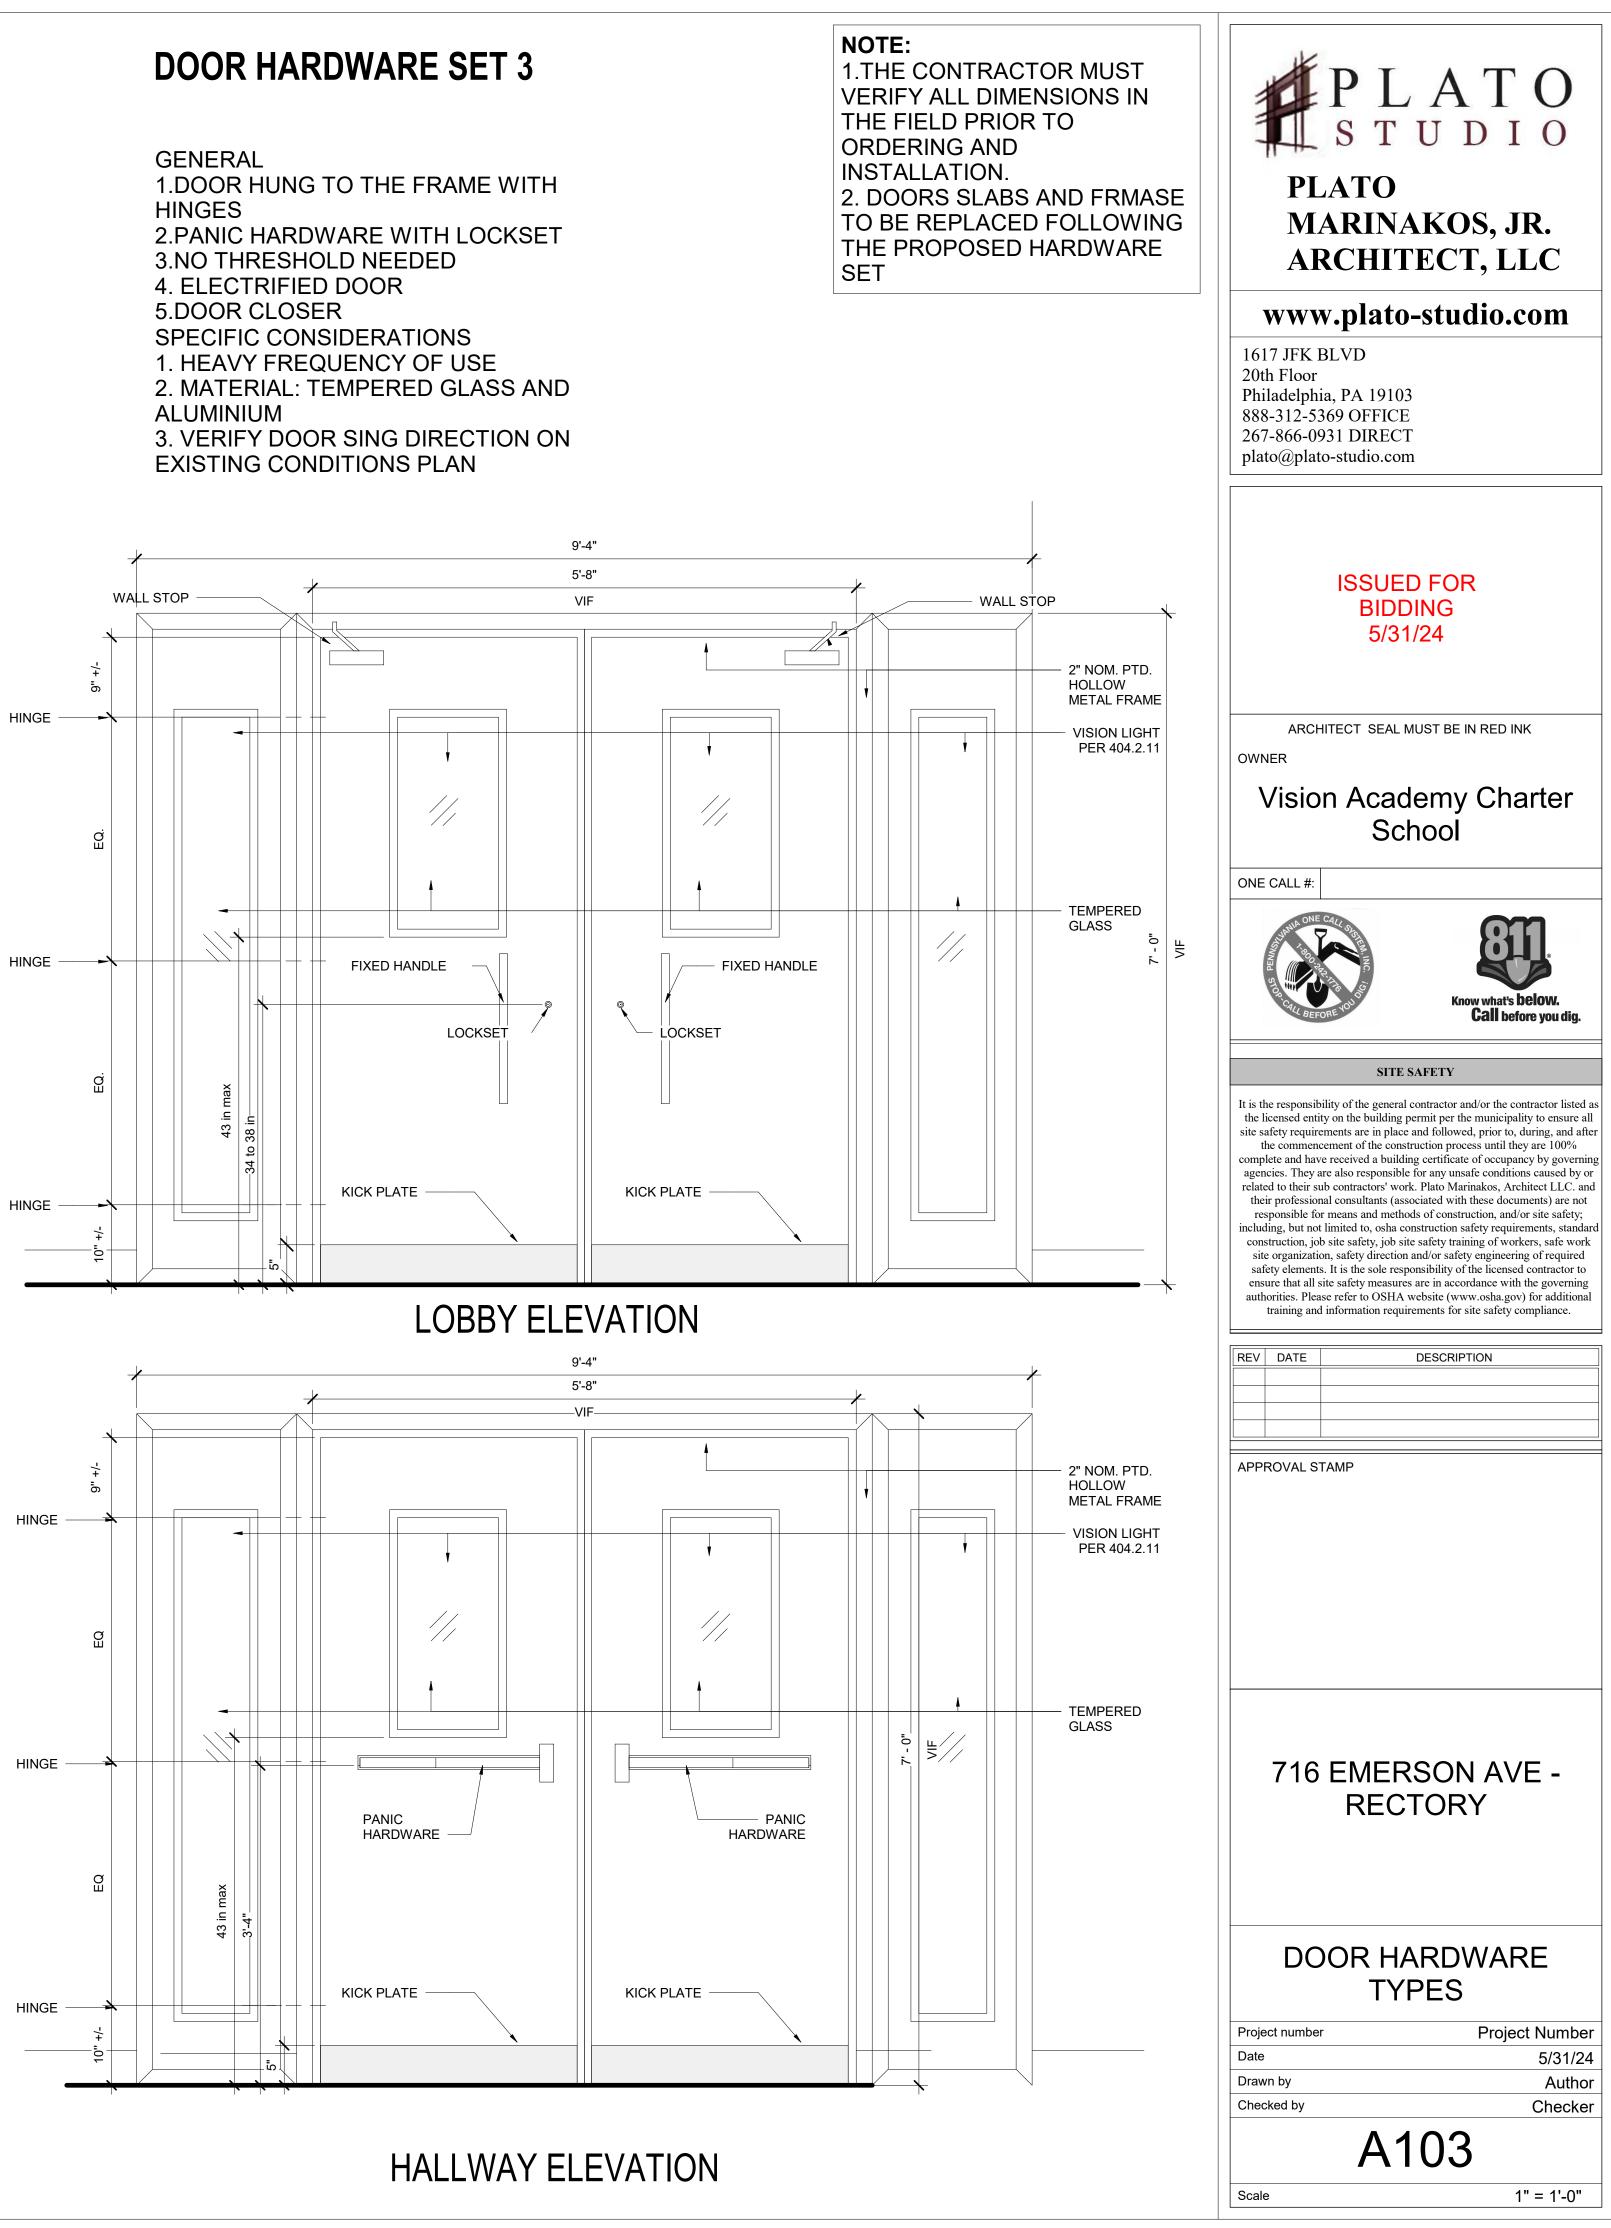

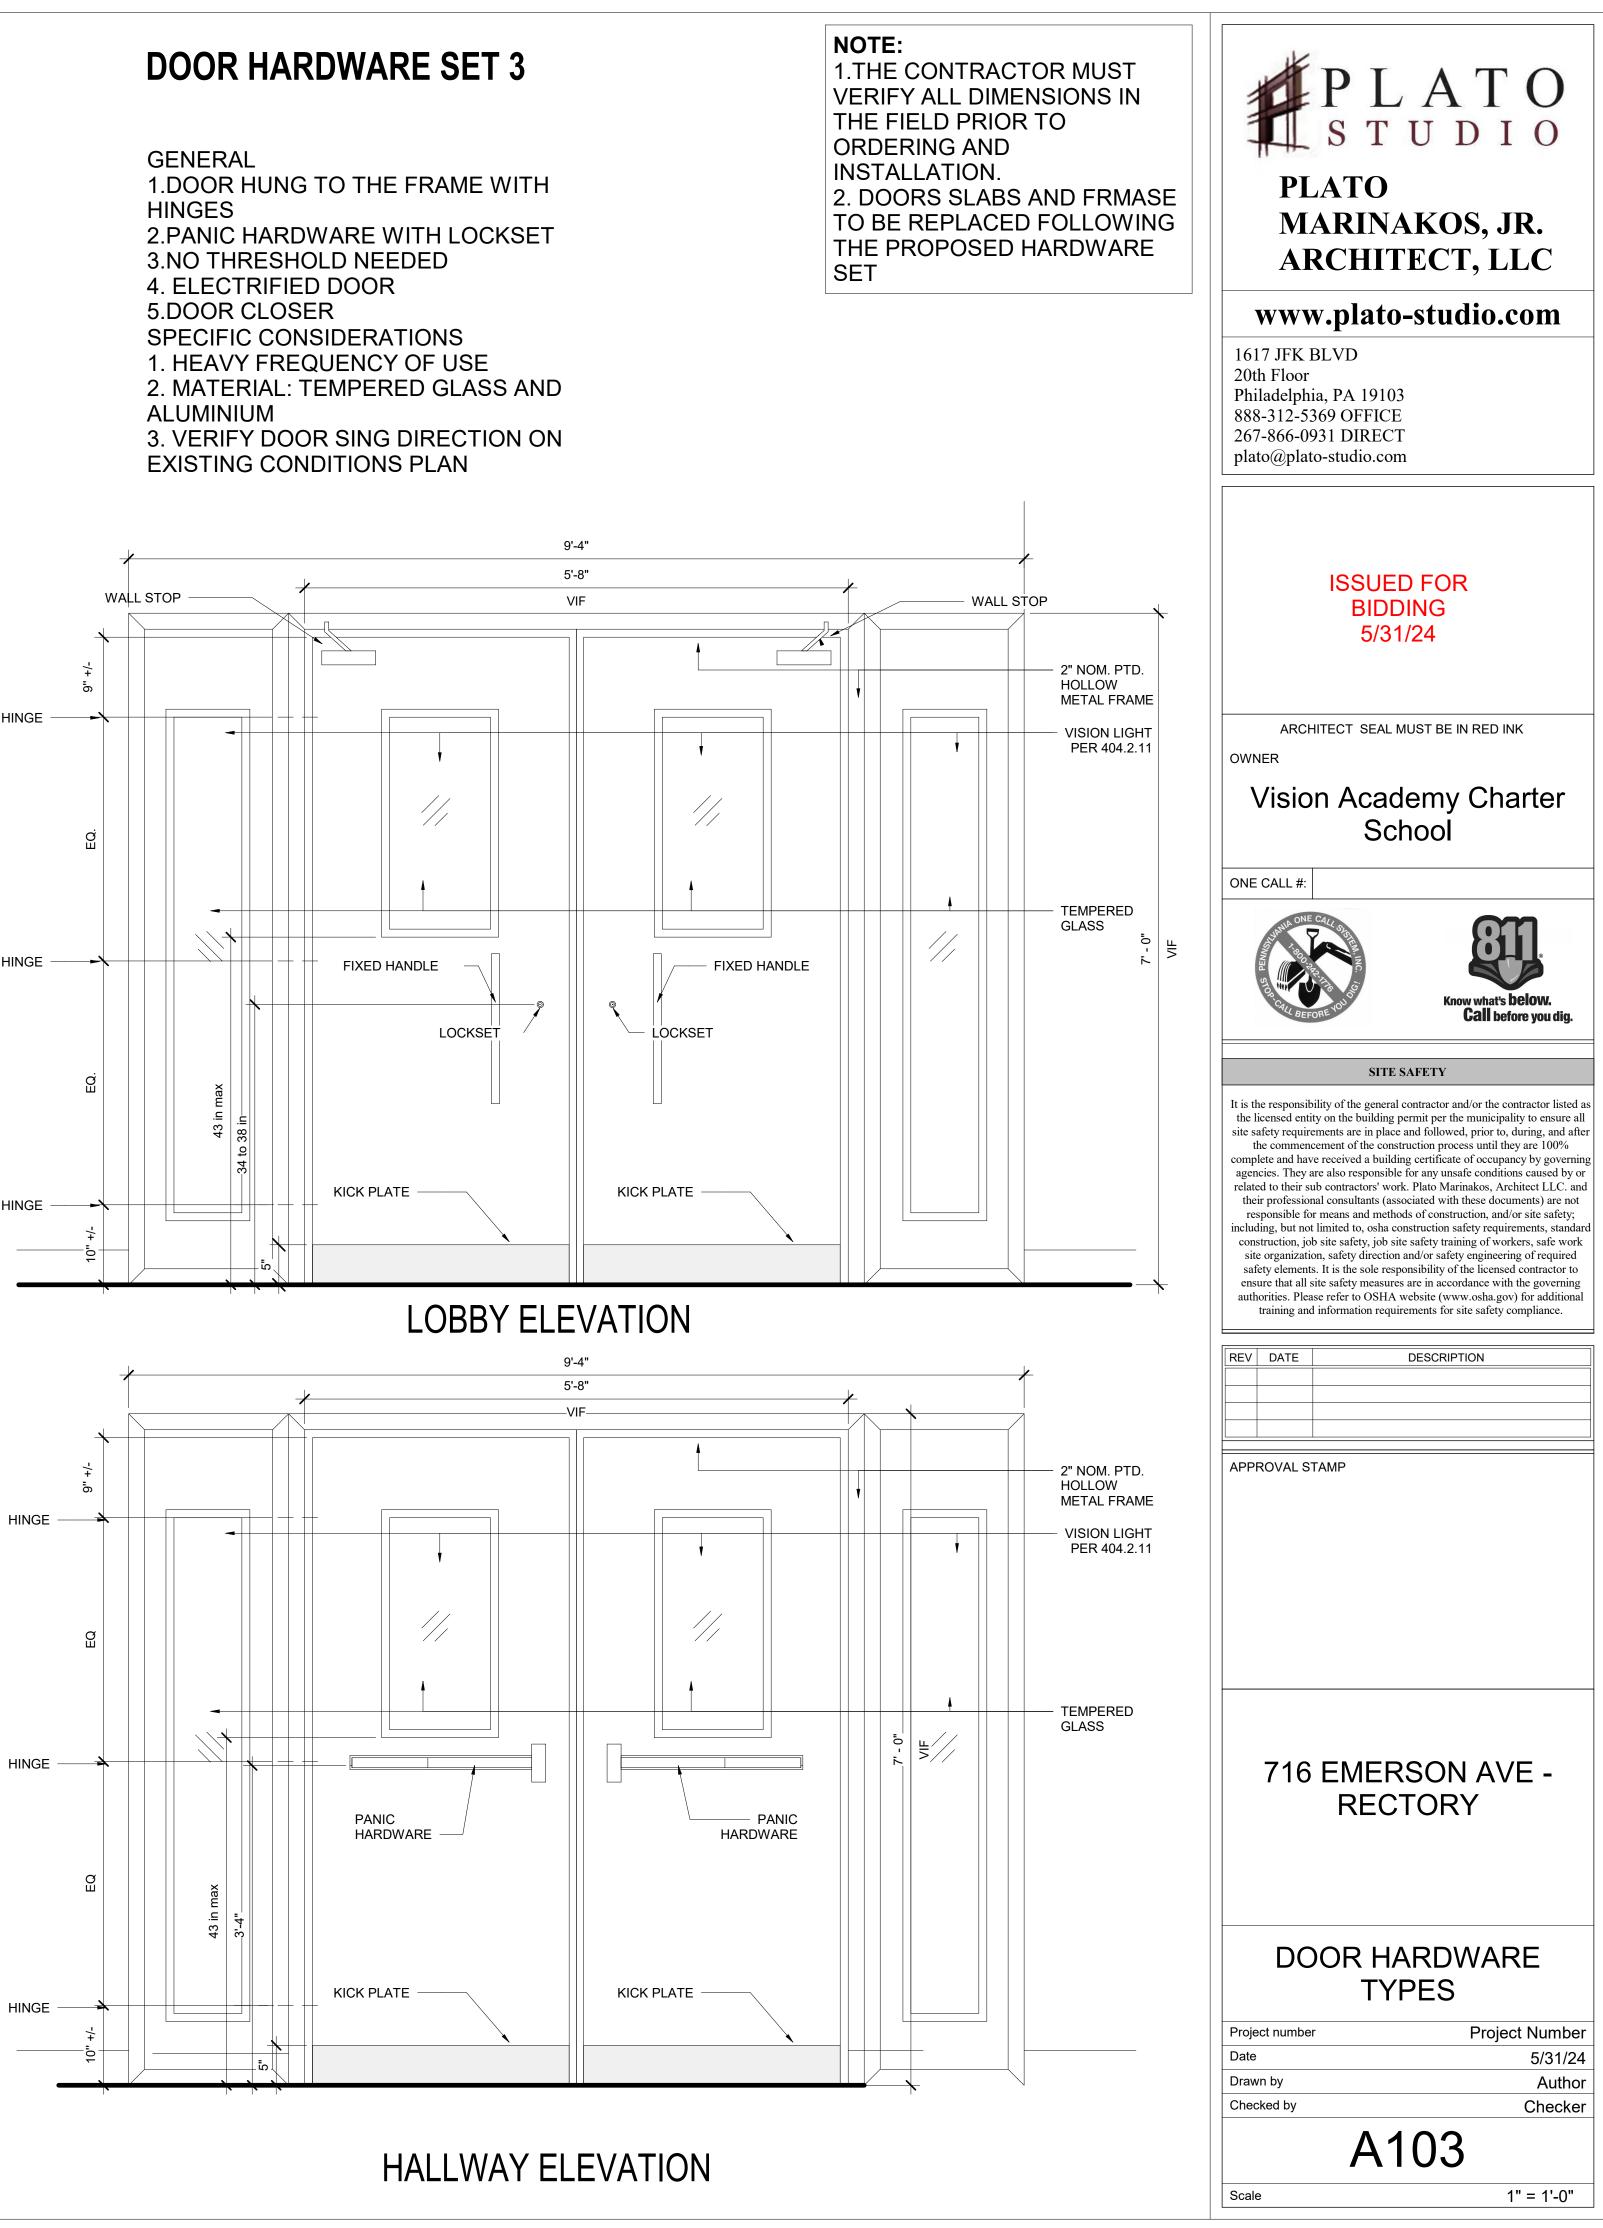

DOOR HARDWARE SET 4


GENERAL 1.DOOR HUNG TO THE FRAME WITH HINGES 2.PANIC HARDWARE WITH LOCKSET 3.THRESHOLD NEEDED 4.SEALED AND PROTECTED DOOR (1HR RATED) 5.ELECTRIFIED DOOR 6.DOOR CLOSER 7.DOOR MUST BE SEALED

SPECIFIC CONSIDERATIONS

1. HEAVY FREQUENCY OF USE

2. EXPOSED TO WEATHER/CLIMATE

3. MATERIAL: TEMPERED GLASS AND ALUMINIUM

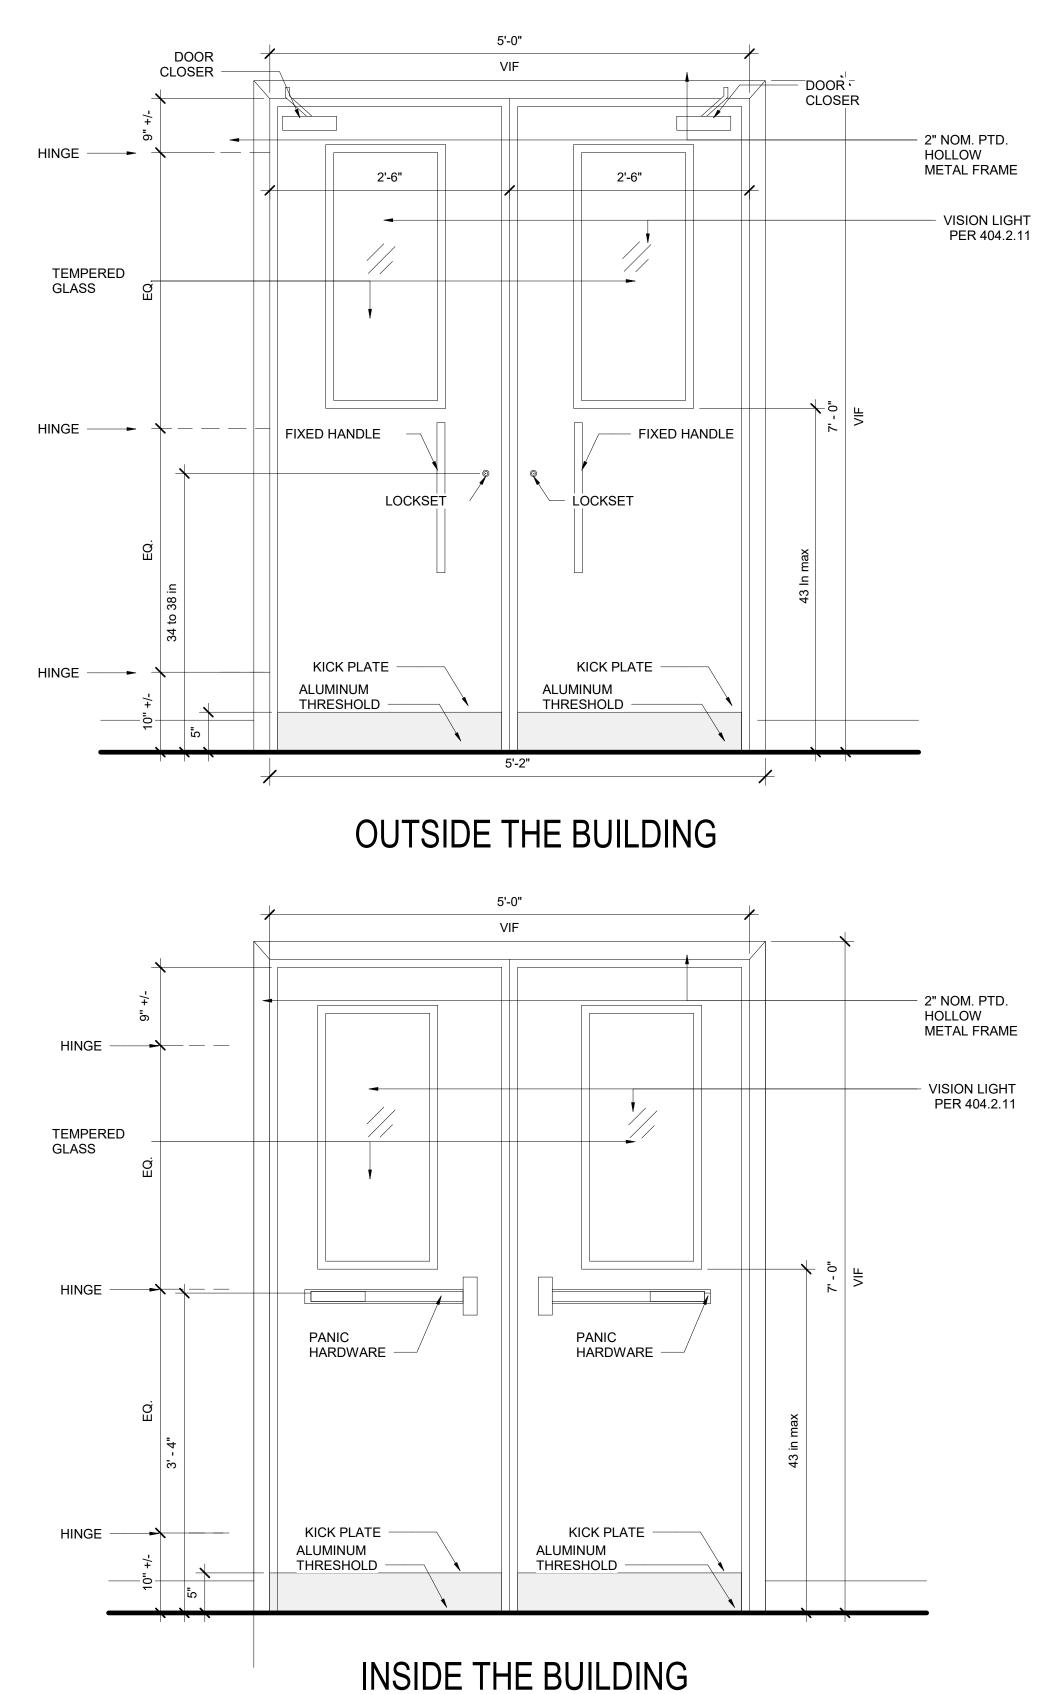

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