

# DOOR SCHEDULE1 PANEL HARDWARE MARK Level WIDTH HEIGHT SET DOOR 2 FIRST FLOOR 2'-6" 7'-0" 2 1 DOOR 1 SIDEWALK 5'-0" 7'-0" 1 1 GRAND TOTAL: 2 3'-0" 7'-0" 1


### WINDOW SCHEDULE

		UNIT DIMENSIONS	
NUMBER	TYPE	HEIGHT	WIDTH
1	A	4'-5"	3'-1"
2	A	4'-5"	3'-1"
A: 2			
4	В	5'-0"	3'-3"
3	В	5'-0"	3'-3"
B: 2			
GRAND TOTAL: 4			


### NOTE:

THE PROPOSED HARDWARE SET

1.THE CONTRACTOR MUST VERIFY ALL DIMENSIONS IN THE FIELD PRIOR TO ORDERING AND INSTALLATION.
2. DOORS SLABS AND FRMASE TO BE REPLACED FOLLOWING

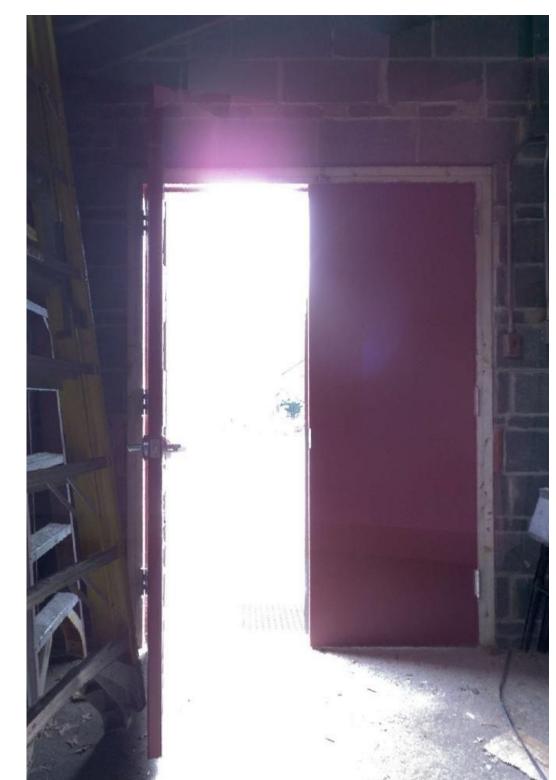



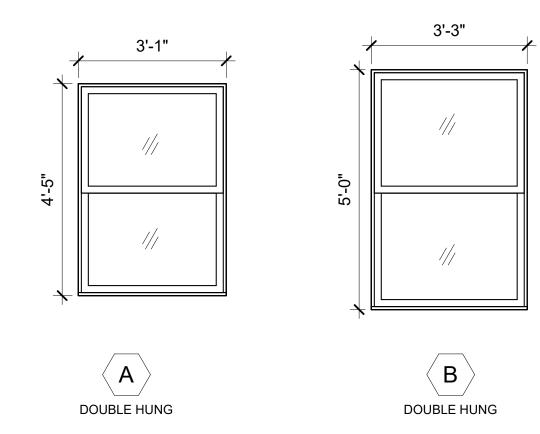


ALL GLAZED FENESTRATION TO HAVE A MAXIMUM U-FACTOR OF 0.35 AND SHGC OF 0.40

\ WINDOW TYPES

SCALE: 1/2" = 1'-0"



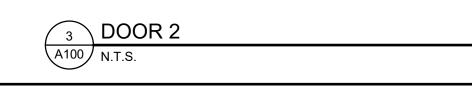

# **DOOR HARDWARE SET 1**

GENERAL

1.DOOR HUNG TO THE FRAME WITH HINGES

2.PANIC HARDWARE WITH LOCKSET

3.THRESHOLD NEEDED 4.SEALED AND PROTECTED DOOR (1HR RATED)

5.ELECTRIFIED DOOR


6.DOOR CLOSER
7.DOOR MUST BE SEALED

SPECIFIC CONSIDERATIONS


1 HEAVY ERECLIENCY OF USE

1. HEAVY FREQUENCY OF USE
2. EXPOSED TO WEATHER/CLIMATE

3. MATERIAL: TEMPERED GLASS AND ALUMINIUM

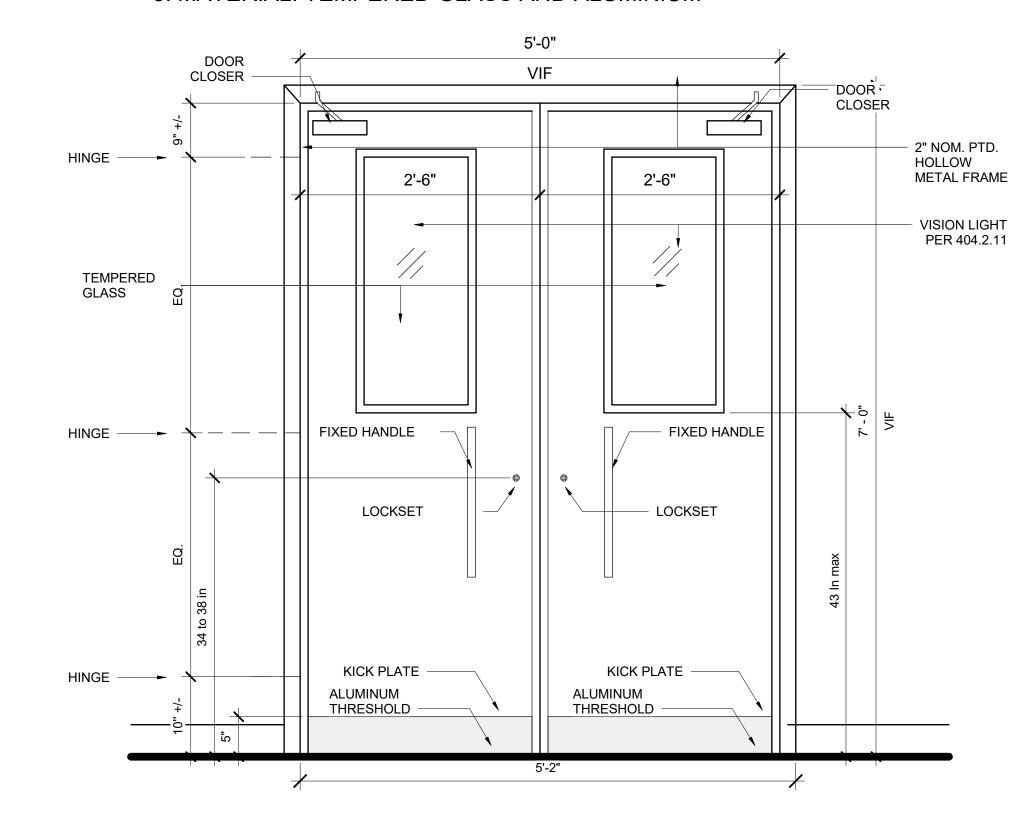

# OUTSIDE THE BUILDING

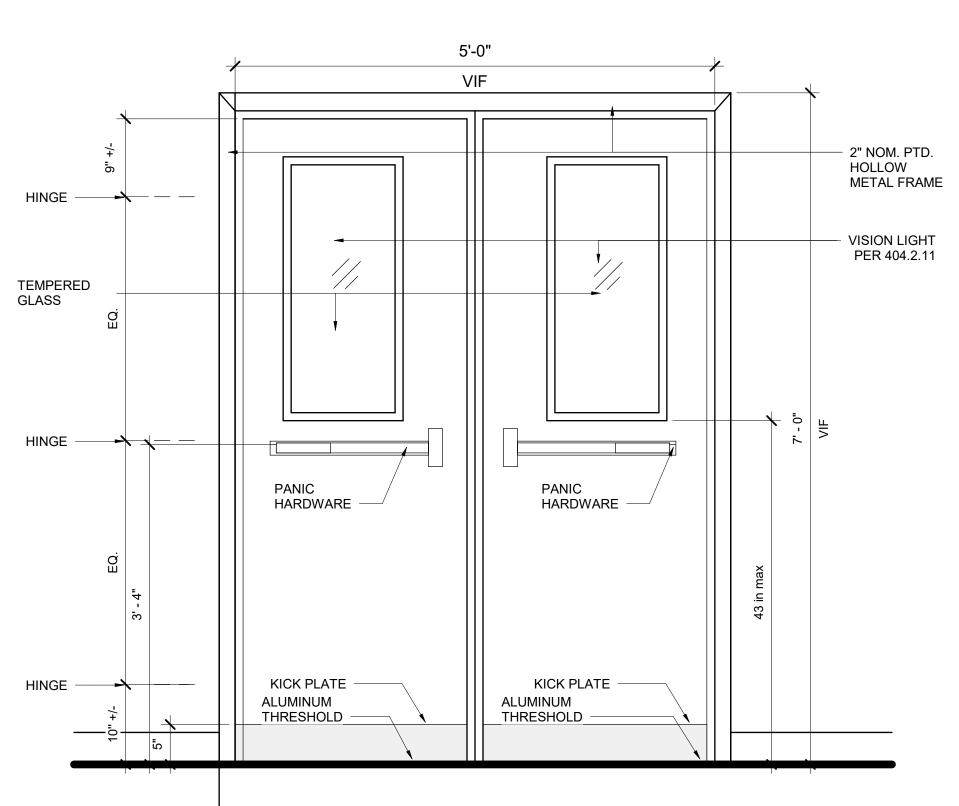

# INSIDE THE BUILDING


# **DOOR HARDWARE SET 2**

### GENERAL


- 1.DOOR HUNG TO THE FRAME WITH HINGES
- 2.PANIC HARDWARE WITH LOCKSET
- 3.THRESHOLD NEEDED
- 4.NOT ELECTRIFIED DOOR 5.DOOR CLOSER

### 3.DOON GLOGEN

- SPECIFIC CONSIDERATIONS
- 1. HEAVY FREQUENCY OF USE 2. MATERIAL: TEMPERED GLASS AND
- ALUMINIUM
- 3. VERIFY DOOR SING DIRECTION ON EXISTING

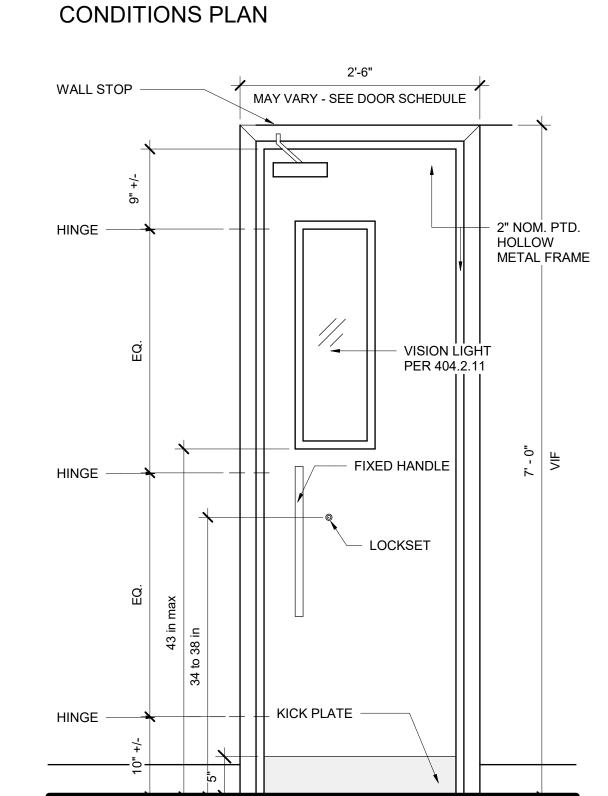

# INSIDE THE GARAGE

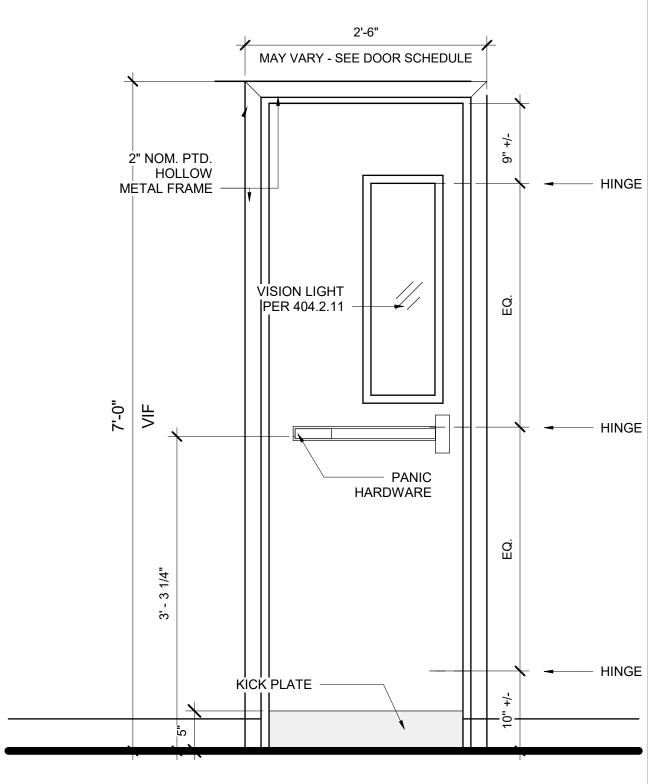

**OUTSIDE THE GARAGE** 



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> ISSUED FOR BIDDING 5/31/24

ARCHITECT SEAL MUST BE IN RED INK

OWNER

Vision Academy Charter School

ONE CALL #:





### SITE SAFETY

It is the responsibility of the general contractor and/or the contractor listed as the licensed entity on the building permit per the municipality to ensure all site safety requirements are in place and followed, prior to, during, and after the commencement of the construction process until they are 100% complete and have received a building certificate of occupancy by governing agencies. They are also responsible for any unsafe conditions caused by or related to their sub contractors' work. Plato Marinakos, Architect LLC. and their professional consultants (associated with these documents) are not responsible for means and methods of construction, and/or site safety; including, but not limited to, osha construction safety requirements, standard construction, job site safety, job site safety training of workers, safe work site organization, safety direction and/or safety engineering of required safety elements. It is the sole responsibility of the licensed contractor to ensure that all site safety measures are in accordance with the governing authorities. Please refer to OSHA website (www.osha.gov) for additional

REV DATE DESCRIPTION

APPROVAL STAMP

EMERSON SCHOOL GUARD HOUSE Lansdowne, PA. 00000

# **EXISTING CONDITIONS**

Project number

Date

Drawn by

Checked by

Project Number

5/31/24

Author

Checker

A100

As indicated